


1 LEVEL 06 FLOOR FINISH PLAN
SCALE 1:200

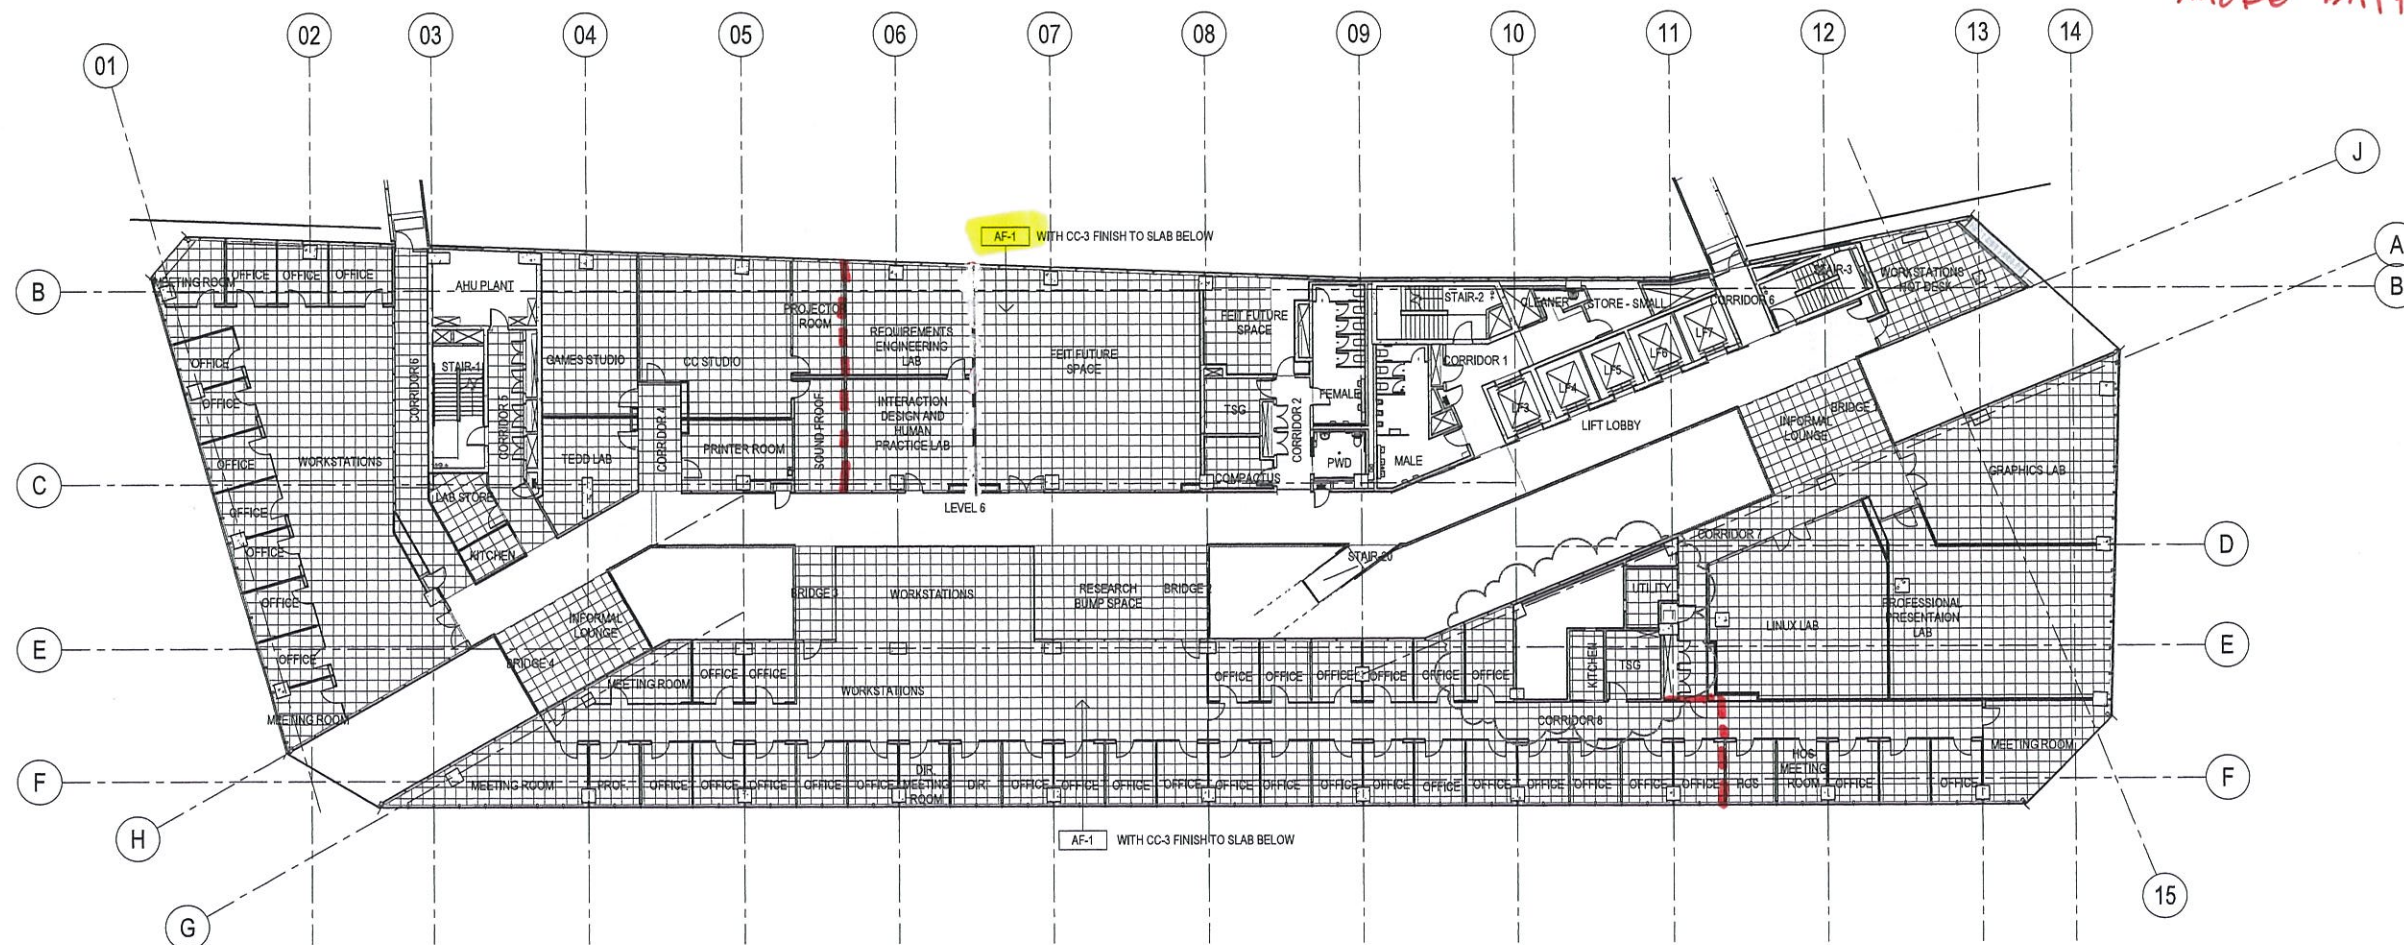

2 LEVEL 06 RAISED FLOOR PLAN
SCALE 1:200

For Construction

FLOOR FINISH LEGEND	
CODE	DESCRIPTION
AF-1	Raised metal access floor
CC-3	Sealer to concrete floor - clear
CC-21	Heavy-duty, urethane floor finish, r10 slip resistance
CC-22	Heavy-duty, urethane floor finish, r10 slip resistance
CPT-1	Carpet Tiles (general)
CPT-2	Carpet tiles - bridge link
ST-11	Expanded metal safety flooring for interior use
VS-1	Vinyl tile flooring (Bridge Links)
VS-2	Vinyl tile flooring (dry laboratories)
VS-3	Vinyl tile safety flooring and covered skirting (kitchen & utilities)
VS-4	Vinyl sheet and covered skirting (antistatic)

23.12.2011
95% DOC ISSUE APP 2

No.	Date	Revision or reason for issue	Approved By
C	15.12.2011	95% DOCUMENTATION ISSUE	NT
B	28.10.2011	75% DOCUMENTATION ISSUE	NT
A	26.06.2011	50% DOCUMENTATION ISSUE - INTERIORS	NT

Scale / North Point
1:100 @ A1 0 1 2 3 5M
1:200 @ A3

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Project Name
UTS BROADWAY BUILDING
UNIVERSITY OF TECHNOLOGY, SYDNEY



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Drawing Title
CITY CAMPUS BROADWAY
BUILDING ELEVEN LEVEL 06 ARCH
INTERIOR
FLOOR FINISHES
PLAN

Project Number 7352	Drawn By JW	Checked By PN	Approved By NT	Date App. DEC 11
Drawing Scale 1:200	Drawing Status PRELIM	Sheet A1	Rev No 1	
UTS Drg File Name CB1105IP	UTS Drg File No 23009			