


General Notes
Do not scale from drawing. Use marked dimensions.
To be read in conjunction with all other Consultant's drawings.
The Architect to be immediately notified of any discrepancies.
Copyright on this drawing retained by the Architect.

Notes

For Construction

No.	Date	Revision or reason for issue	Approved By
A	01-11-11	75% CONTRACT DOCUMENT ISSUE	MS
B	23-12-11	95% DOCUMENTATION ISSUE	MS

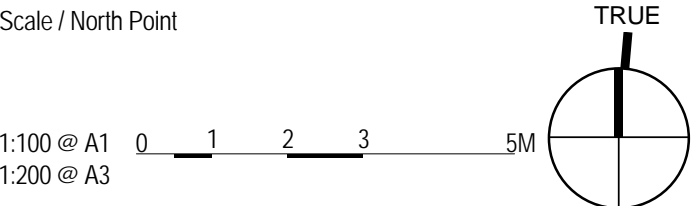


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Denton Corker Marshall
architecture and urban design

Architect
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49 Exhibition Street Melbourne Victoria 3000
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Email melb@dentoncorkermarshall.com.au

Project Name
UTS BROADWAY BUILDING

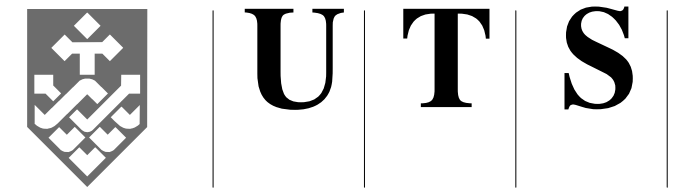


University of Technology, Sydney
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Level 19, Building 1
PO Box 123 Ultimo NSW 2007
Ph: 9514-2830 Fax: 9514-4690

Drawing Title
CITY CAMPUS BROADWAY
BUILDING ELEVEN STRUCTURE
WEST LINK BRIDGE
PLANS


Project Number 44506			
Drawn By DML	Checked By MDS	Approved By JRD	Date App.
Drawing Scale 1 : 50		Drawing Status	Sheet A1
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EXISTING BUILDING CB10

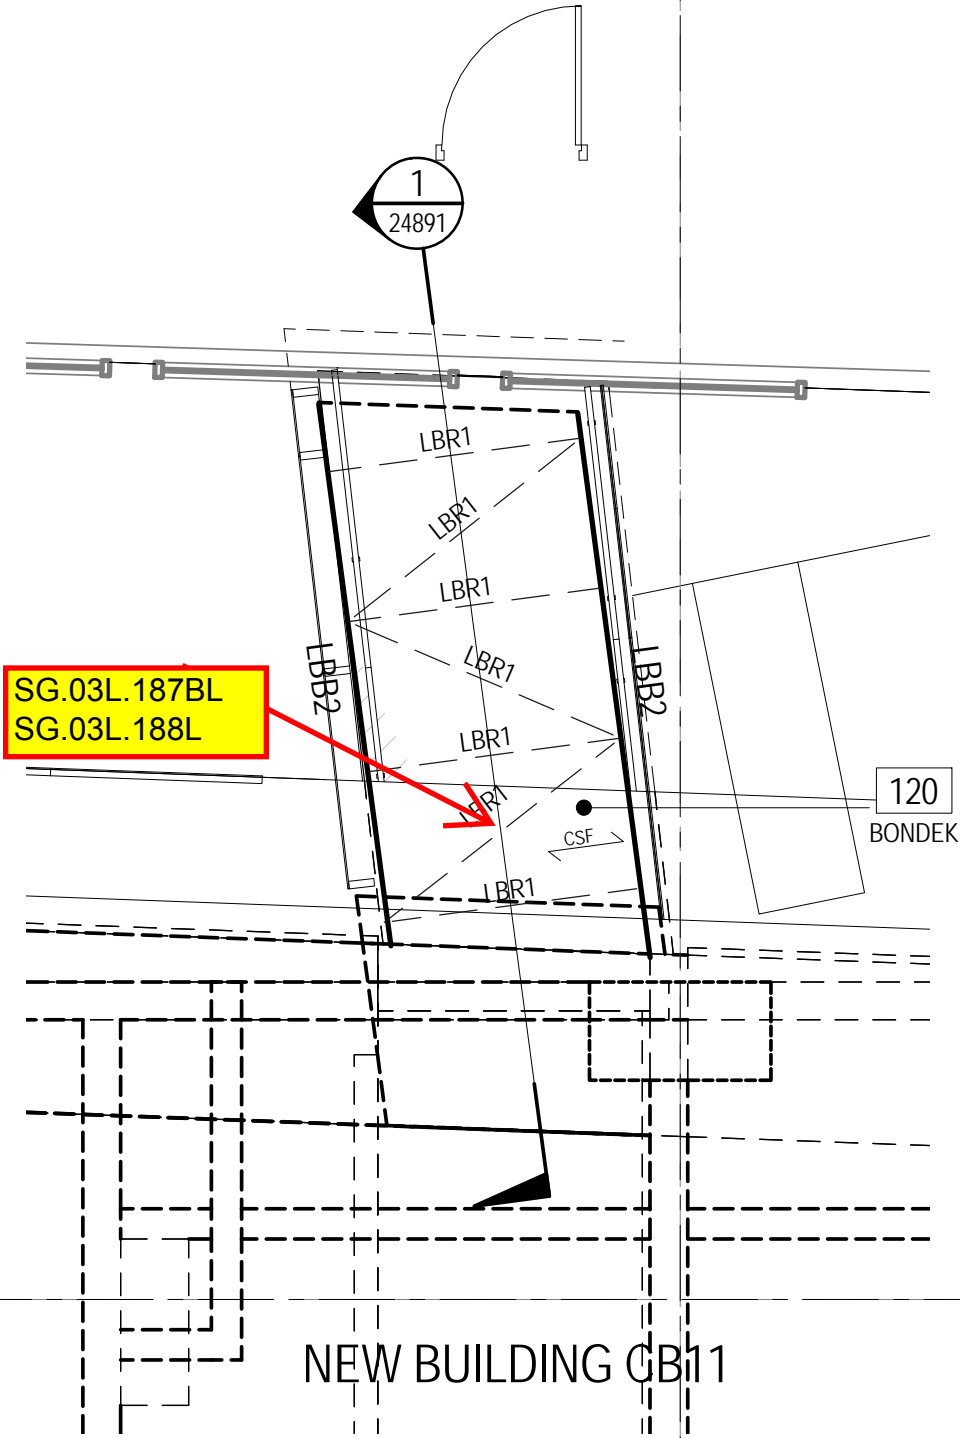


WEST LINK BRIDGE LEVEL 03
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EXISTING BUILDING CB10




WEST LINK BRIDGE LEVEL 04
1 : 50

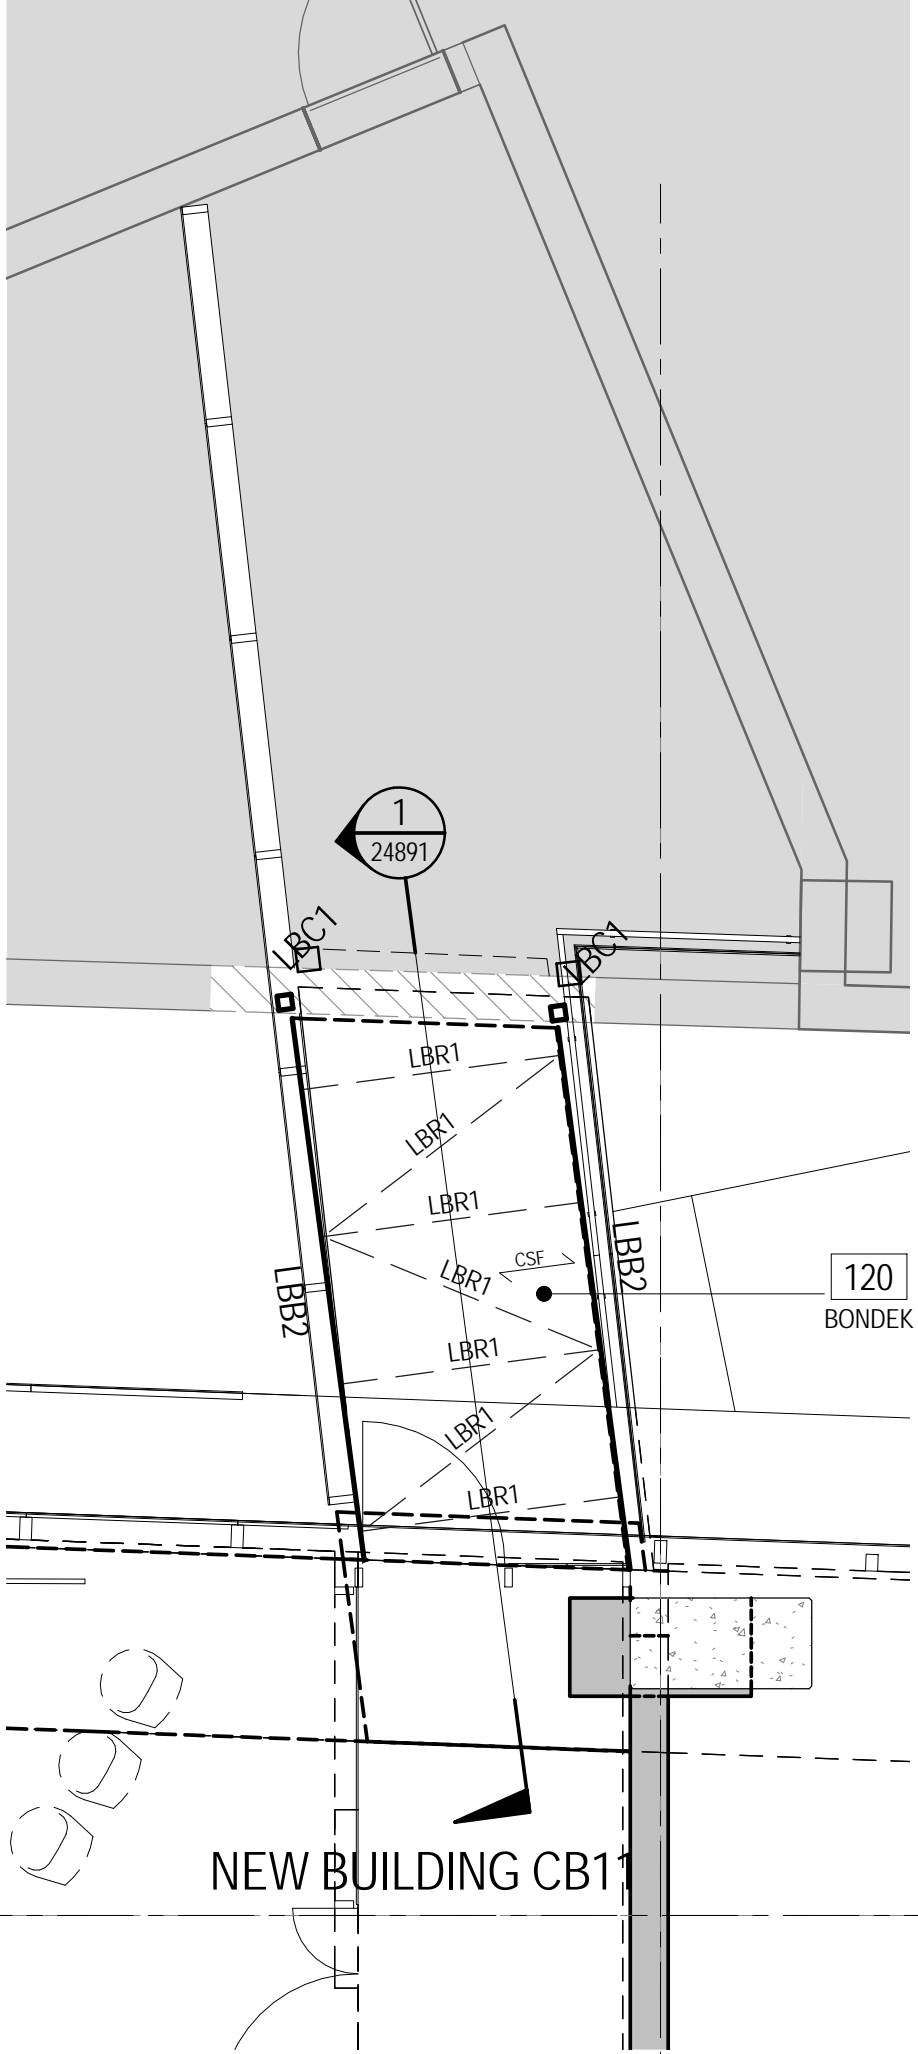EXISTING BUILDING CB10

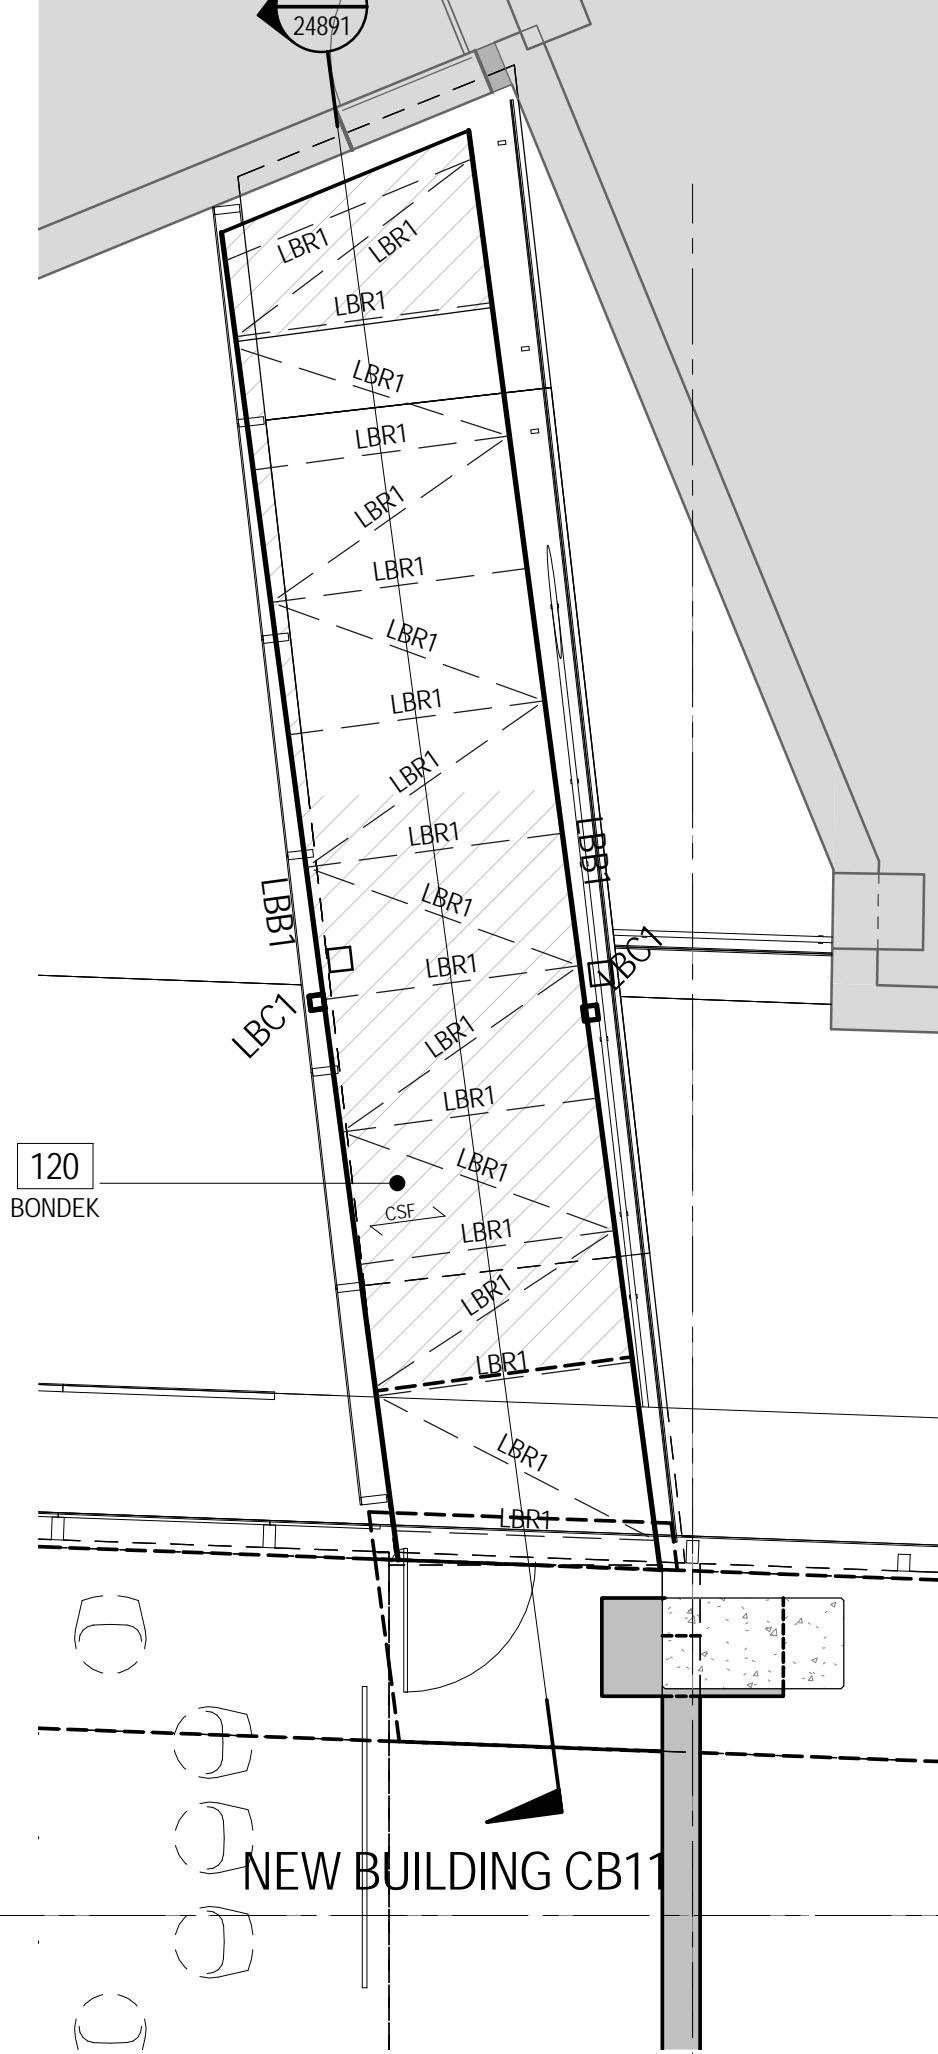

WEST LINK BRIDGE LEVEL 05
1 : 50
WEST LINK BRIDGE LEVEL 06 SIMILAR

EXISTING BUILDING CB10

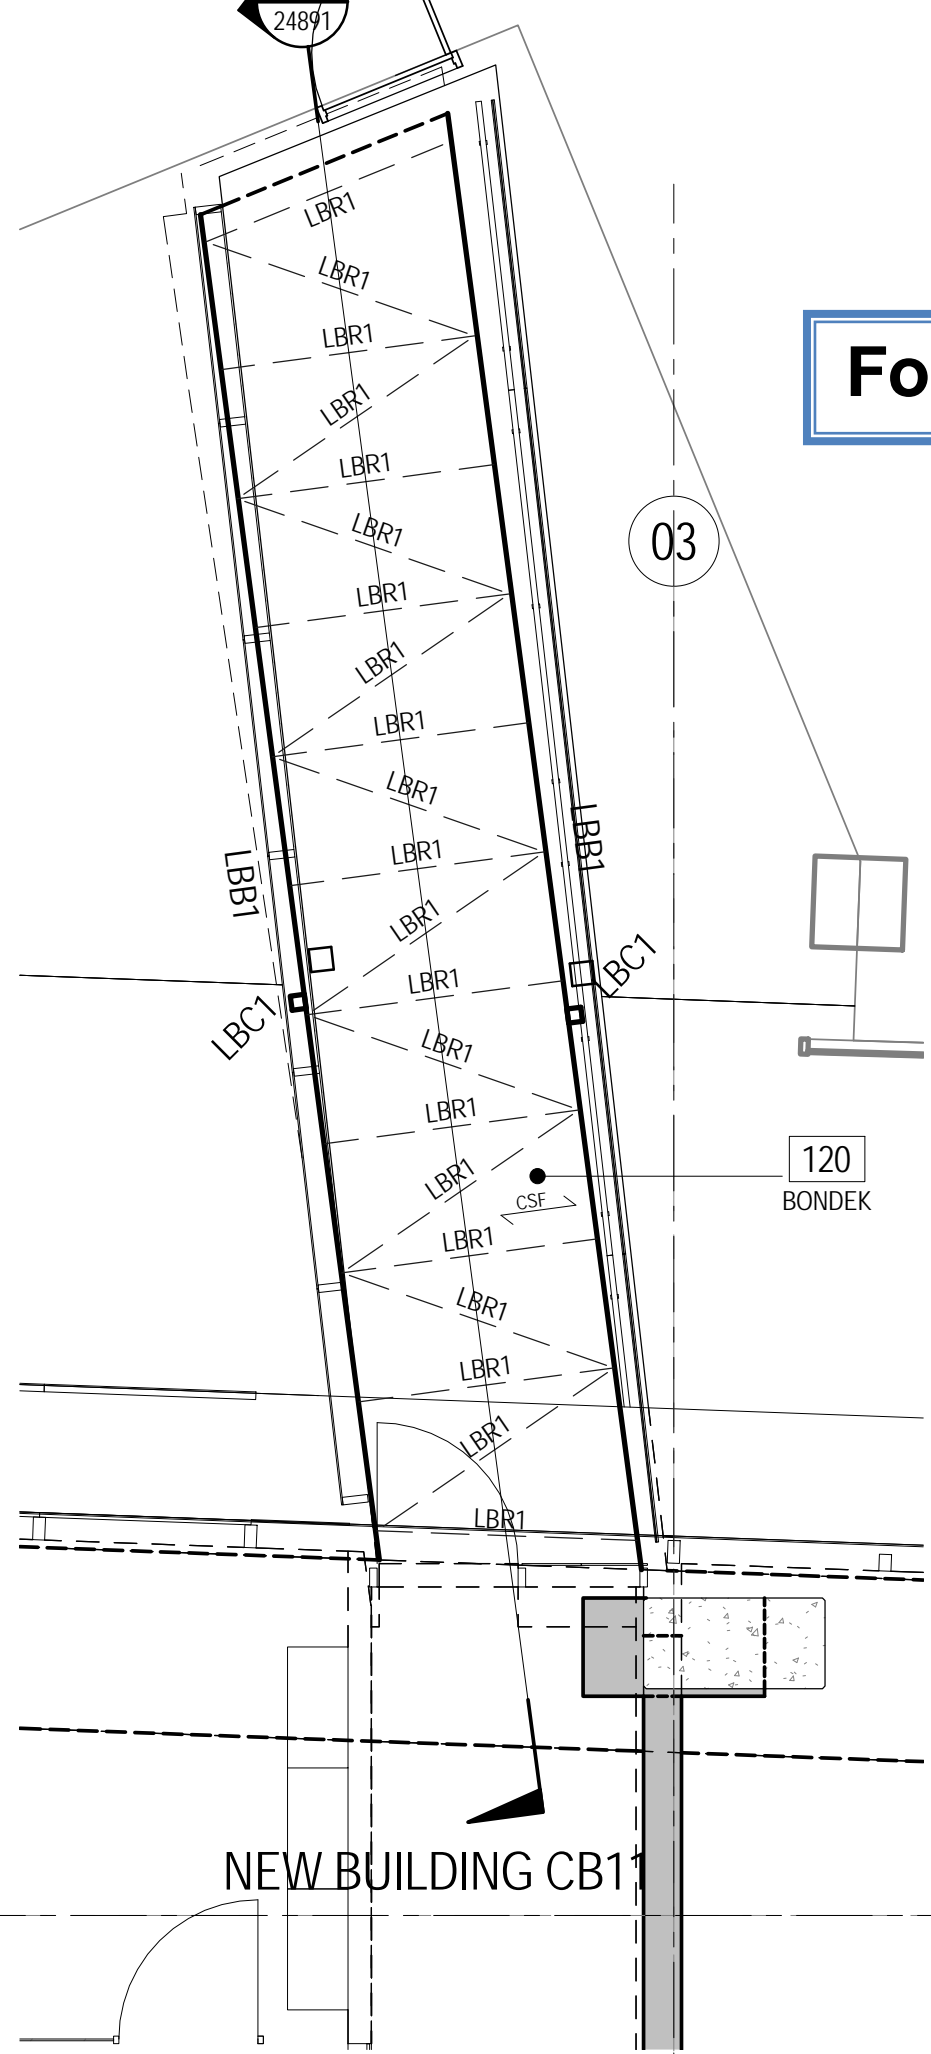

WEST LINK BRIDGE LEVEL 07
1 : 50

LINK BRIDGE STEEL SCHEDULE

MARK	SIZE	REMARKS
LBB1	460 UB 67	BEAM
LBB2	310 UB 40	BEAM
LBR1	75x75x5 EA	

LINK BRIDGE COLUMN SCHEDULE

MARK	SIZE	REMARKS
LBC1	100x100x6.0 SHS	COLUMN